DEVELOPER / OWNERS

KEN & YVONNE MANDEVILLE

4335 COVENTRY STATION RD.

ORLEANS, VT 05860 802-754-2334

9 HARBOR RIDGE RD.

SOUTH BURLINGTON

VT 05403 802-863-2020

NICK PARENT

architects

GARDNER KILCOYNE architects

147 Allen Brook Lane, Suite 103 Williston, Vermont 05495 Phone 802 655 0145 www.gk-architects.com

Vt. Registration

Struct. Engineer:
JIH Structural
Engineering, Inc.
10 Athens Drive
Essex Junction, VT
05452

roiect·

1 Cherry St. Apartments

1 Cherry Street Essex Junction, VT

Proj. No.: 15-09

Drawing Title:


Site Plan Arch.

Scale:
1"=10'
Date:
5/4/16
Rev:
1 8/26/16
2 12/22/16

Drawn by:

SHEET No.

S-1

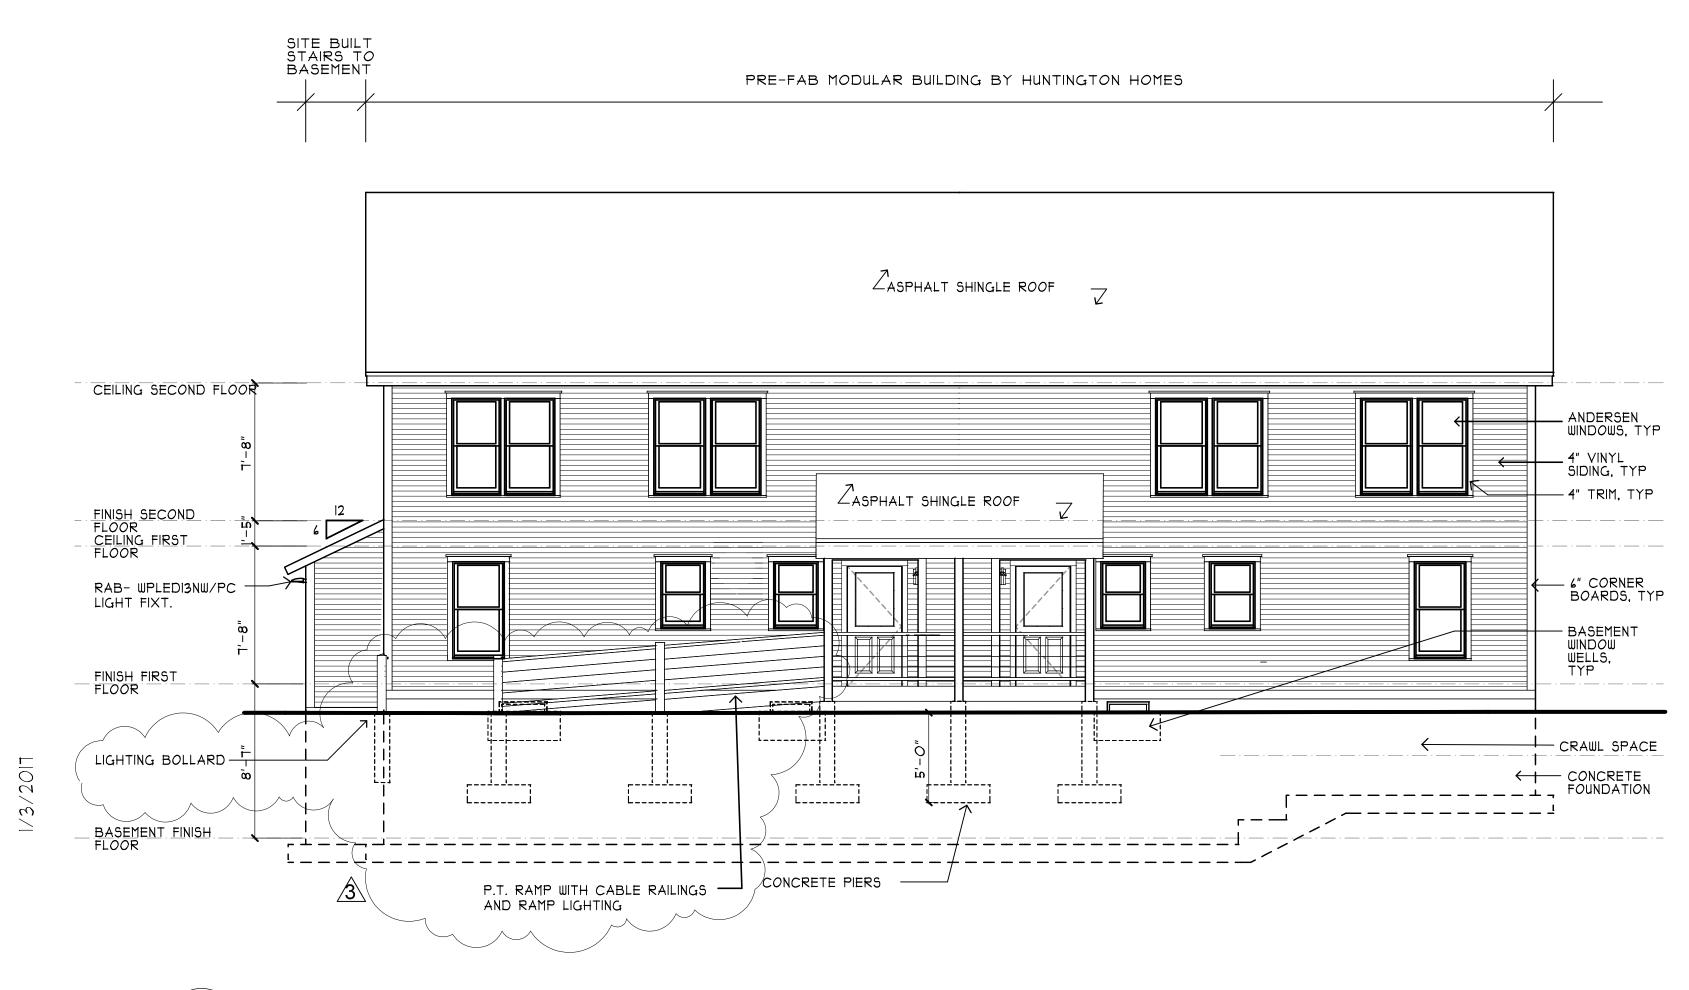

CHERRY STREET ELEVATION

A2.1 3/16"=1'-0"




SITE BUILT ENTRY ∉ RAMP PRE-FAB MODULAR BUILDING BY HUNTINGTON HOMES ASPHALT SHINGLE ROOF Phone 802 655 0145 www.gk-architects.com CEILING SECOND FLOOR - ANDERSEN WINDOWS, TYP RAB-WPI8NW/PC 4" VINYL SIDING, TYP FINISH SECOND FLOOR CEILING FIRST FLOOR ASPHALT SHINGLE ROOF ----4" TRIM, TYP CORNERS, TYP FINISH FIRST FLOOR

2 DRIVEWAY ELEVATION

A2.1 3/16"=1'-0"

BASEMENT. FINISH. FLOOR

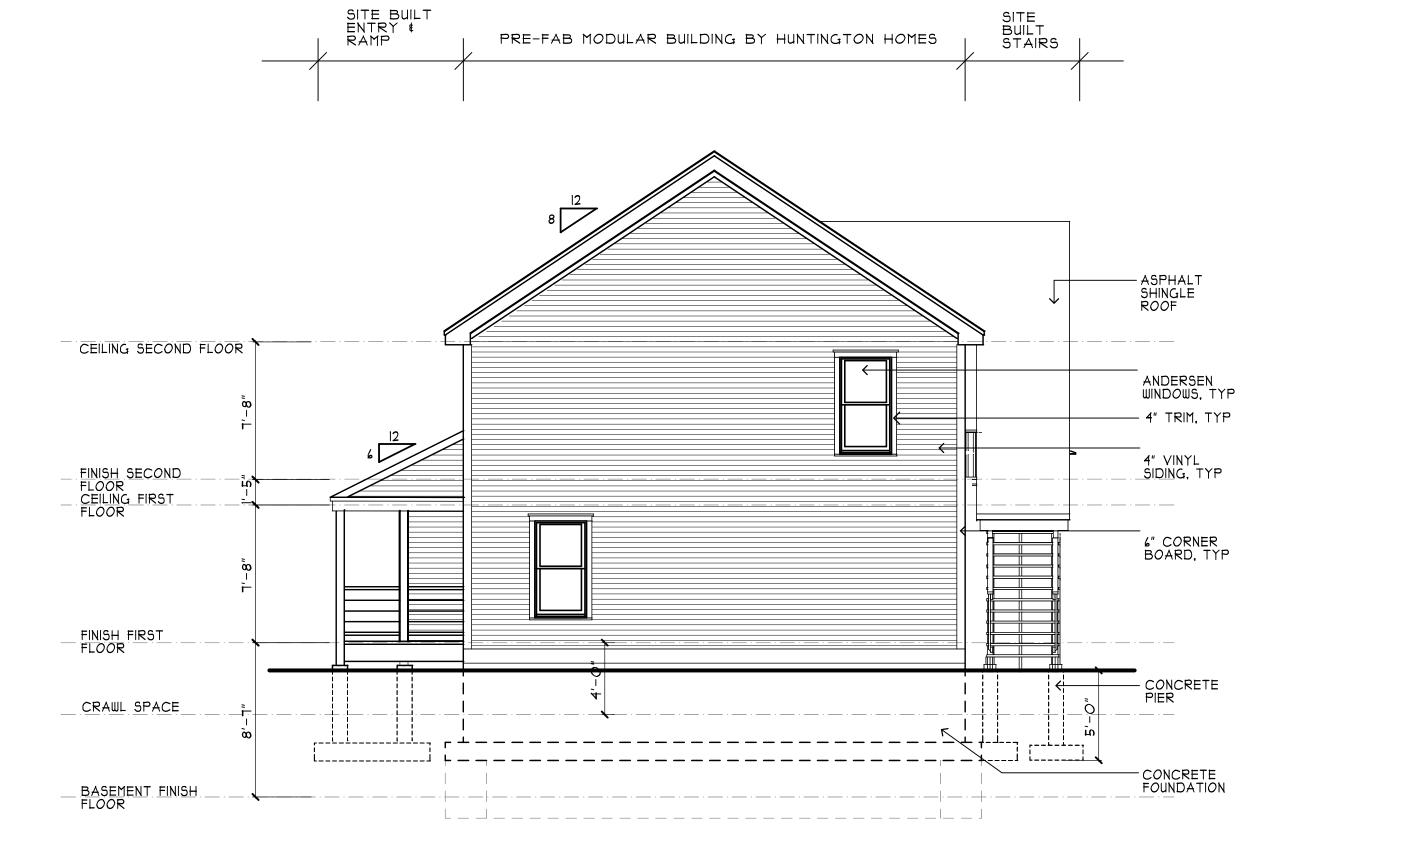


POST OFFICE SQUARE ELEVATION

A2.1 3/16"=1'-0"



GARDNER 147 Allen Brook Lane, Suite 103 Williston, Vermont 05495

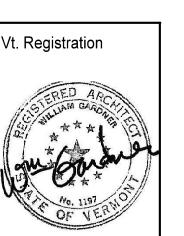

Struct. Engineer: JIH Structural Engineering, Inc. 10 Athens Drive Essex Junction, VT 05452

Project:

1 Cherry St. Apartments

1 Cherry Street Essex Junction, VT


Proj. No.:

Drawing Title:

ELEVATIONS

Scale: 3/16"=1'-0" Date: 6/17/16 <u>1</u> 8/26/16 **2** 9/20/16 Drawn by:


SHEET No.

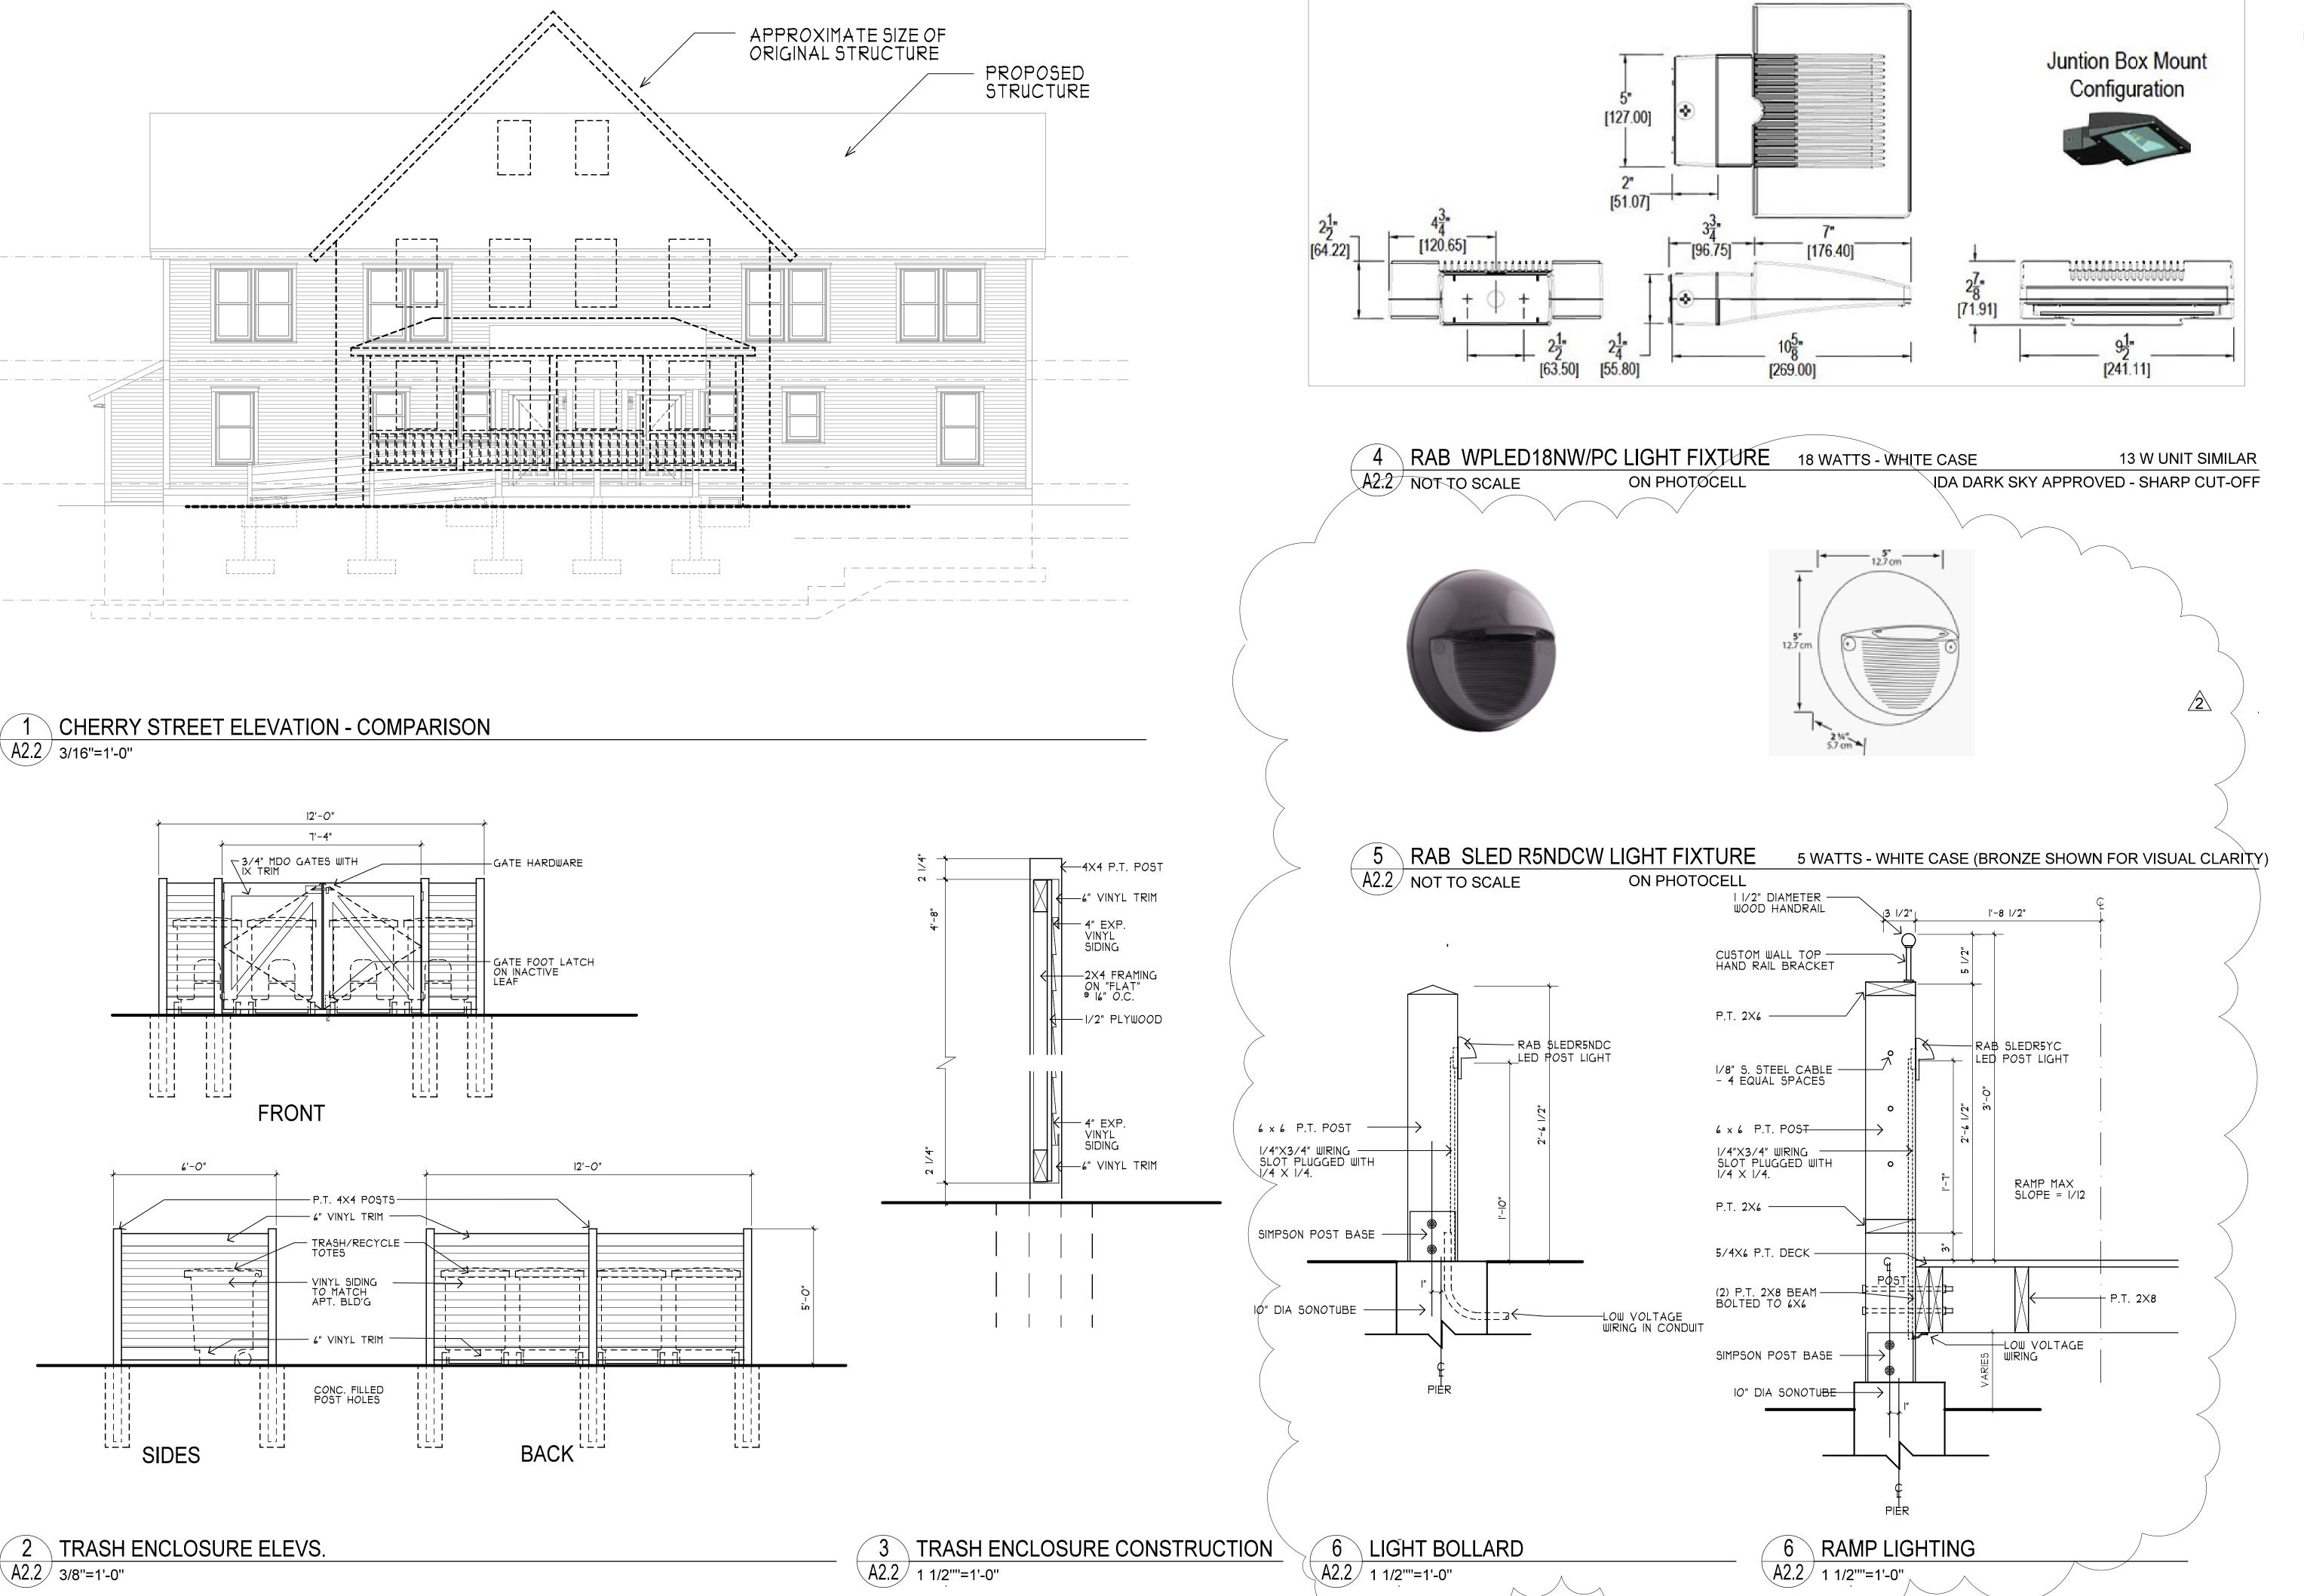

architects

GARDNER KILCOYNE architects

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Struct. Engineer:
JIH Structural
Engineering, Inc.
10 Athens Drive
Essex Junction, VT
05452

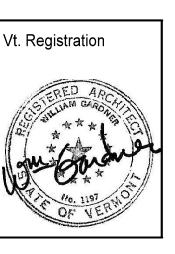Project:

1 Cherry St. Apartments

1 Cherry Street Essex Junction, VT

Proj. No.: 15**-**09

Drawing Title:

awing ride.

SITE DETAILS

Scale:
AS NOTED

Date:
5/4/16


1 9/20/16 2 12/22/16

Rev:

Drawn by: BG/SL

SHEET No.

A2.2

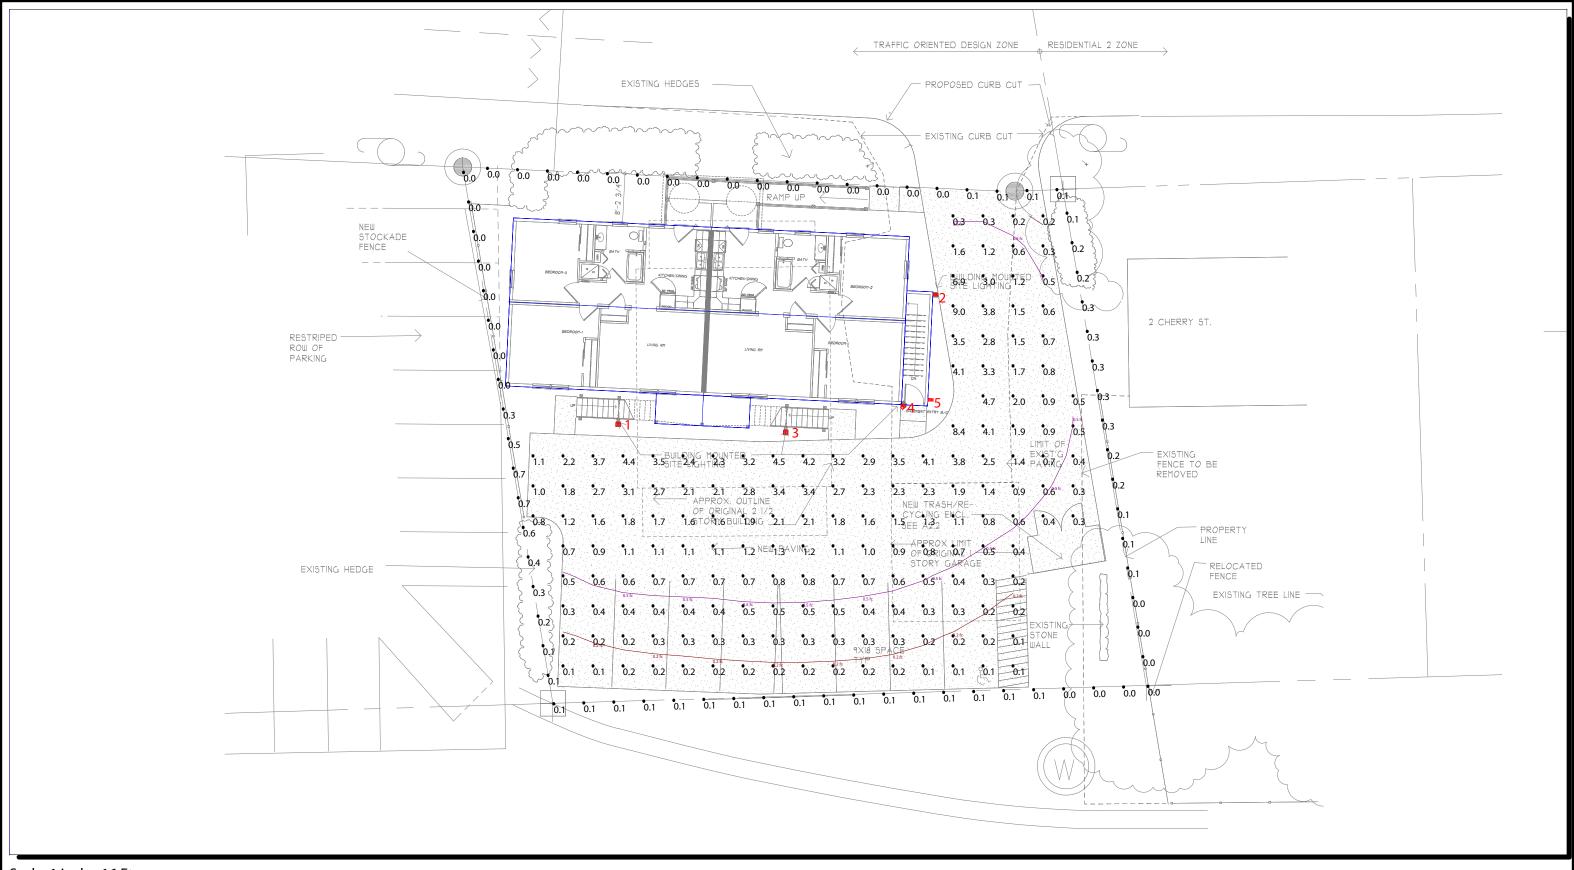

Scale: 1 inch= 16 Ft.



Prepared For: Hozack, Inc. 7877 South 180 St Kent, WA 98032 Job Name: 1 Cherry St. Apartments Essex Junction, VT

Lighting Layout

Version B

Scale: as noted

Drawn By: MSkow

The Lighting Analysis, ezLayout, Energy Analysis and/or Visual Simulation ("Lighting Design") provided by the RAB Lighting Inc. ("RAB") represent an anticipated prediction of lighting system performance based upon design parameters and information supplied by others. These design parameters and information provided by others have not been field verified by RAB and therefore actual measured r esults may vary from the actual field conditions. RAB recommends that design parameters and other information be field verified to reduce variation.

RAB neither warranties, either implied or stated with regard to actual measured light levels or energy consumption levels as compared to those illustrated by the Lighting Design. RAB neither warranties, either implied or stated, nor represents the appropriateness, completeness or suitability of the Lighting Design intent as compliant with any applicable regulatory code requirements with the exception of those specifically stated on drawings created and submitted by RAB. The Lighting design is issued, in whole or in part, as advisory documents for informational purposes and is not intended for construction nor as being part of a project's construction documentation package.

 $Filename: F: \label{lem:filename: F: Jobs! Laboration} Files \label{filename: F: Jobs! Laboration} Files \la$

Calculation Summary	alculation Summary										
Label	CalcType	Units	Avg	Max	Min	Avg/Min	Max/Min	Description	PtSpcLr	PtSpcTb	Meter Type
Parking	Illuminance	Fc	1.36	9.0	0.1	13.60	90.00	Readings taken at 0' 0" AFG	5	5	Horizontal
Property Line	Illuminance	Fc	0.12	0.7	0.0	N.A.	N.A.	Readings taken at 0' 0" AFG	5	N.A.	Horizontal

Luminaiı	Luminaire Schedule											
Symbol	Qty	Tag	Label	Arrangement	Lum. Lumens	Arr. Lum. Lumens	LLF	Description	Lum. Watts	Arr. Watts	Total Watts	Filename
	2	Α	WPLED13	SINGLE	1197	1197	1.000	Wallpack	14.8	14.8	29.6	WPLED13 - Cool - ITL82640.IES
	3	В	WPLED18	SINGLE	2044	2044	1.000	Wallpack	19.8	19.8	59.4	WPLED18 - Cool - ITL80280.IES

Expanded Luminaire Location Summary							
LumNo	Tag	X	Υ	MTG HT	Orient	Tilt	
1	В	4.444	54.15	14	267.832	0	
2	Α	57.497	75.765	7	357.257	0	
3	В	32.377	52.829	14	267.832	0	
4	В	51.984	57.096	14	311.752	0	
5	Α	56.678	58.246	7	357.257	0	
Total Quantity: 5							






WPLED13

WPLED18

NOTES:

- * The light loss factor (LLF) is a product of many variables, only lamp lumen depreciation (LLD) has been applied to the calculated results unless otherwise noted. The LLD is the result (quotient) of mean lumens / initial lumens per lamp manufacturers' specifications.
- * Illumination values shown (in footcandles) are the predicted results for planes of calculation either horizontal, vertical or inclined as designated in the calculation summary. Meter orientation is normal to the plane of calculation.
- * The calculated results of this lighting simulation represent an anticipated prediction of system performance. Actual measured results may vary from the anticipated performance and are subject to means and methods which are beyond the control of RAB Lighting Inc.
- * Mounting height determination is job site specific, our lighting simulations assume a mounting height (insertion point of the luminaire symbol) to be taken at the top of the symbol for ceiling mounted luminaires and at the bottom of the symbol for all other luminaire mounting configurations.
- * RAB Lighting Inc. luminaire and product designs are protected under U.S. and International intellectual property laws. Patents issued or pending apply.

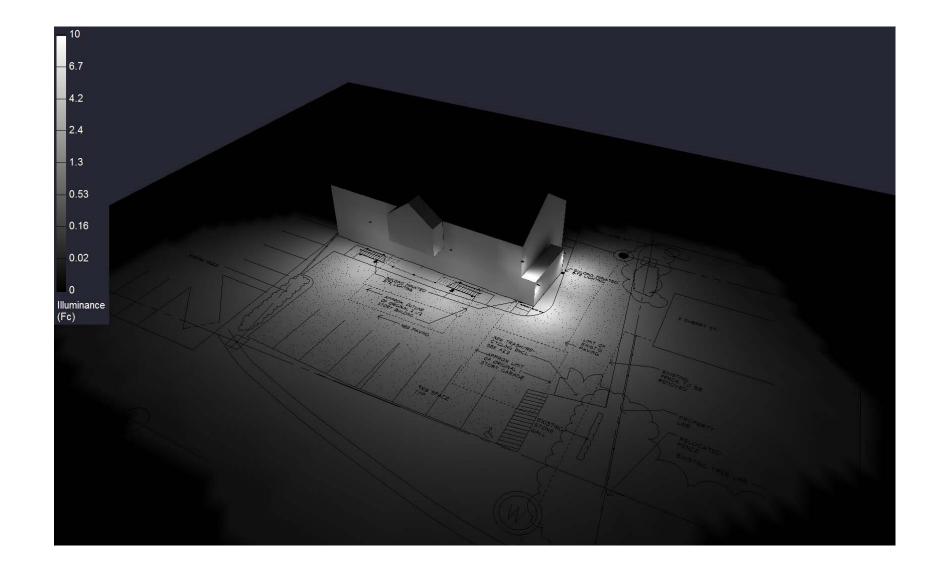



Prepared For: Hozack, Inc. 7877 South 180 St Kent, WA 98032 Job Name: 1 Cherry St. Apartments Essex Junction, VT

Lighting Layout Version B

Scale: as noted							
Date:9/6/2016	CASE #: 00057532						
Filename: 1 Cherry St Apartments 00053269A.AGI							
Drawn By: MSkow							

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Filename: F:\Jobs!\1 Cherry St Apartments\Working Files\AGI\1 Cherry St Apartments 00053269A.AGI