

17 PARK STREET

CITY OF ESSEX JUNCTION, VERMONT




10/26/2023 11:34:35 AM

ABBREVIATIONS		ARCHITECTURAL SYMBOLS		DRAWING INDEX																								
ADD A/C AT ADJ AFF ALUM APROX ARCH	ADDITIONAL AIR CONDITION(ING) ACOUSTIC TILE ADJUSTABLE ABOVE FINISH FLOOR ALUMINUM APPROXIMATE ARCHITECTURAL	GA GALV GC GL GYP	GAGE GALVANIZED GENERAL CONTRACTOR GLASS GYPSUM	PVC QT R RD REINF REOD REV RM RO	POLYVINYL CHLORIDE QUARRY TILE RADIUS, RISER ROOF DRAIN, ROAD REINFORCEMENT REQUIRED REVISION ROOM ROUGH OPENING	ARCHITECTURAL SHEET LIST <table border="1"> <thead> <tr> <th>SHEET #</th> <th>SHEET NAME</th> </tr> </thead> <tbody> <tr><td>A000</td><td>COVER SHEET</td></tr> <tr><td>A101</td><td>PARKING LEVEL PLAN</td></tr> <tr><td>A102</td><td>FIRST FLOOR PLAN</td></tr> <tr><td>A103</td><td>SECOND FLOOR PLAN</td></tr> <tr><td>A104</td><td>THIRD FLOOR PLAN</td></tr> <tr><td>A105</td><td>FOURTH FLOOR PLAN</td></tr> <tr><td>A106</td><td>FIFTH FLOOR PLAN</td></tr> <tr><td>A201</td><td>EXTERIOR ELEVATIONS</td></tr> <tr><td>A202</td><td>EXTERIOR ELEVATIONS</td></tr> <tr><td>A901</td><td>PERSPECTIVE</td></tr> </tbody> </table>	SHEET #	SHEET NAME	A000	COVER SHEET	A101	PARKING LEVEL PLAN	A102	FIRST FLOOR PLAN	A103	SECOND FLOOR PLAN	A104	THIRD FLOOR PLAN	A105	FOURTH FLOOR PLAN	A106	FIFTH FLOOR PLAN	A201	EXTERIOR ELEVATIONS	A202	EXTERIOR ELEVATIONS	A901	PERSPECTIVE
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A901	PERSPECTIVE																											
BD BLDG BLKG BSMT	BOARD BUILDING BLOCKING BASEMENT	HHGT HC HORIZ H/C HM HVAC	HEIGHT HOLLOW CORE HORIZONTAL HANDICAP HOLLOW METAL HEATING, VENTILATION, & A/C	S SCH SCW SECT SHT SIM SL SPEC SQ STD STL SUSP S, STL	SOUTH SCHEDULE SOLID CORE WOOD SECTION SHEET SIMILAR SLOPE SPECIFICATION SQUARE STANDARD STEEL SUSPENDED STAINLESS STEEL																							
CAB CER CJ CL CLG C.H. CMU COL CONC CONST CONT CPT CT	CABINET CERAMIC CONTROL JOINT CLEAR, CLEARANCE CEILING CEILING HEIGHT CONCRETE MASONRY UNIT COLUMN CONCRETE CONSTRUCTION CONTINUOUS CARPET CERAMIC TILE	ID IN INSUL INT INCL JAN, JC JT KIT LAV LAM	INSIDE DIAMETER INCH INSULATION, INSULATED INTERIOR INCLUDED JANITOR'S CLOSET JOINT KITCHEN, KITCHENETTE LAVATORY LAMINATE	T & G TEL TEMP TH, THK THRSLD TOS TOW TYP	TONGUE AND GROOVE TELEPHONE TEMPORARY THICK, THICKNESS THRESHOLD TOP OF STEEL, SLAB TOP OF WALL TYPICAL																							
DET DIA DIM DN DS DWG	DETAIL DIAMETER DIMENSION DOWN DOWNSPOUT DRAWING	MATL MAX MDO MECH MTL MIN MO	MATERIAL MAXIMUM MEDIUM DENSITY OVERLAY MECHANICAL METAL MINIMUM MASONRY OPENING	UNO VCT VERT VEST VIF WVC	UNLESS NOTED OTHERWISE VINYL COMPOSITION TILE VERTICAL VESTIBULE VERIFY IN FIELD VINYL WALL COVERING																							
E EA ELEC ELEV EQ EQUIP EXIST EXP	EAST EACH ELECTRICAL ELEVATION, ELEVATOR EQUAL EQUIPMENT EXISTING EXPANSION	N NIC NO NOM NTS OC OD OPNG OPP	NORTH NOT IN CONTRACT NUMBER NOMINAL NOT TO SCALE ON CENTER OUTSIDE DIAMETER OPENING OPPOSITE	W W/ W/O WD WT WWF WWM	WIDTH, WASTE, WATER, WEST WITH WITHOUT WOOD WEIGHT WELDED WIRE FABRIC WELDED WIRE MESH																							
FD FF FEC F. EXT. FIN FL FT FTG	FLOOR DRAIN FINISHED FLOOR FIRE EXTINGUISHER W/ CABINET FIRE EXTINGUISHER W/O CABINET FINISH FLOOR, FLASHING FOOT, FEET FOOTING	PL PLYWD PRELIM PSI PTD P.T.	PLATE PLYWOOD PRELIMINARY POUNDS PER SQUARE INCH PAINTED PRESSURE TREATED																									

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REVISIONS		
No.	Description	Date

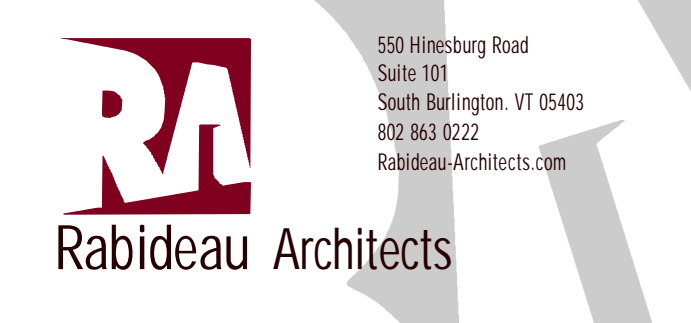

No.	Description	Date

PARKING LEVEL PLAN
SCALE: 1/8" = 1'-0"

17 PARK STREET
CITY OF ESSEX JUNCTION, VERMONT




PROJECT #: 2005

SHEET NUMBER

A101

10/05/23

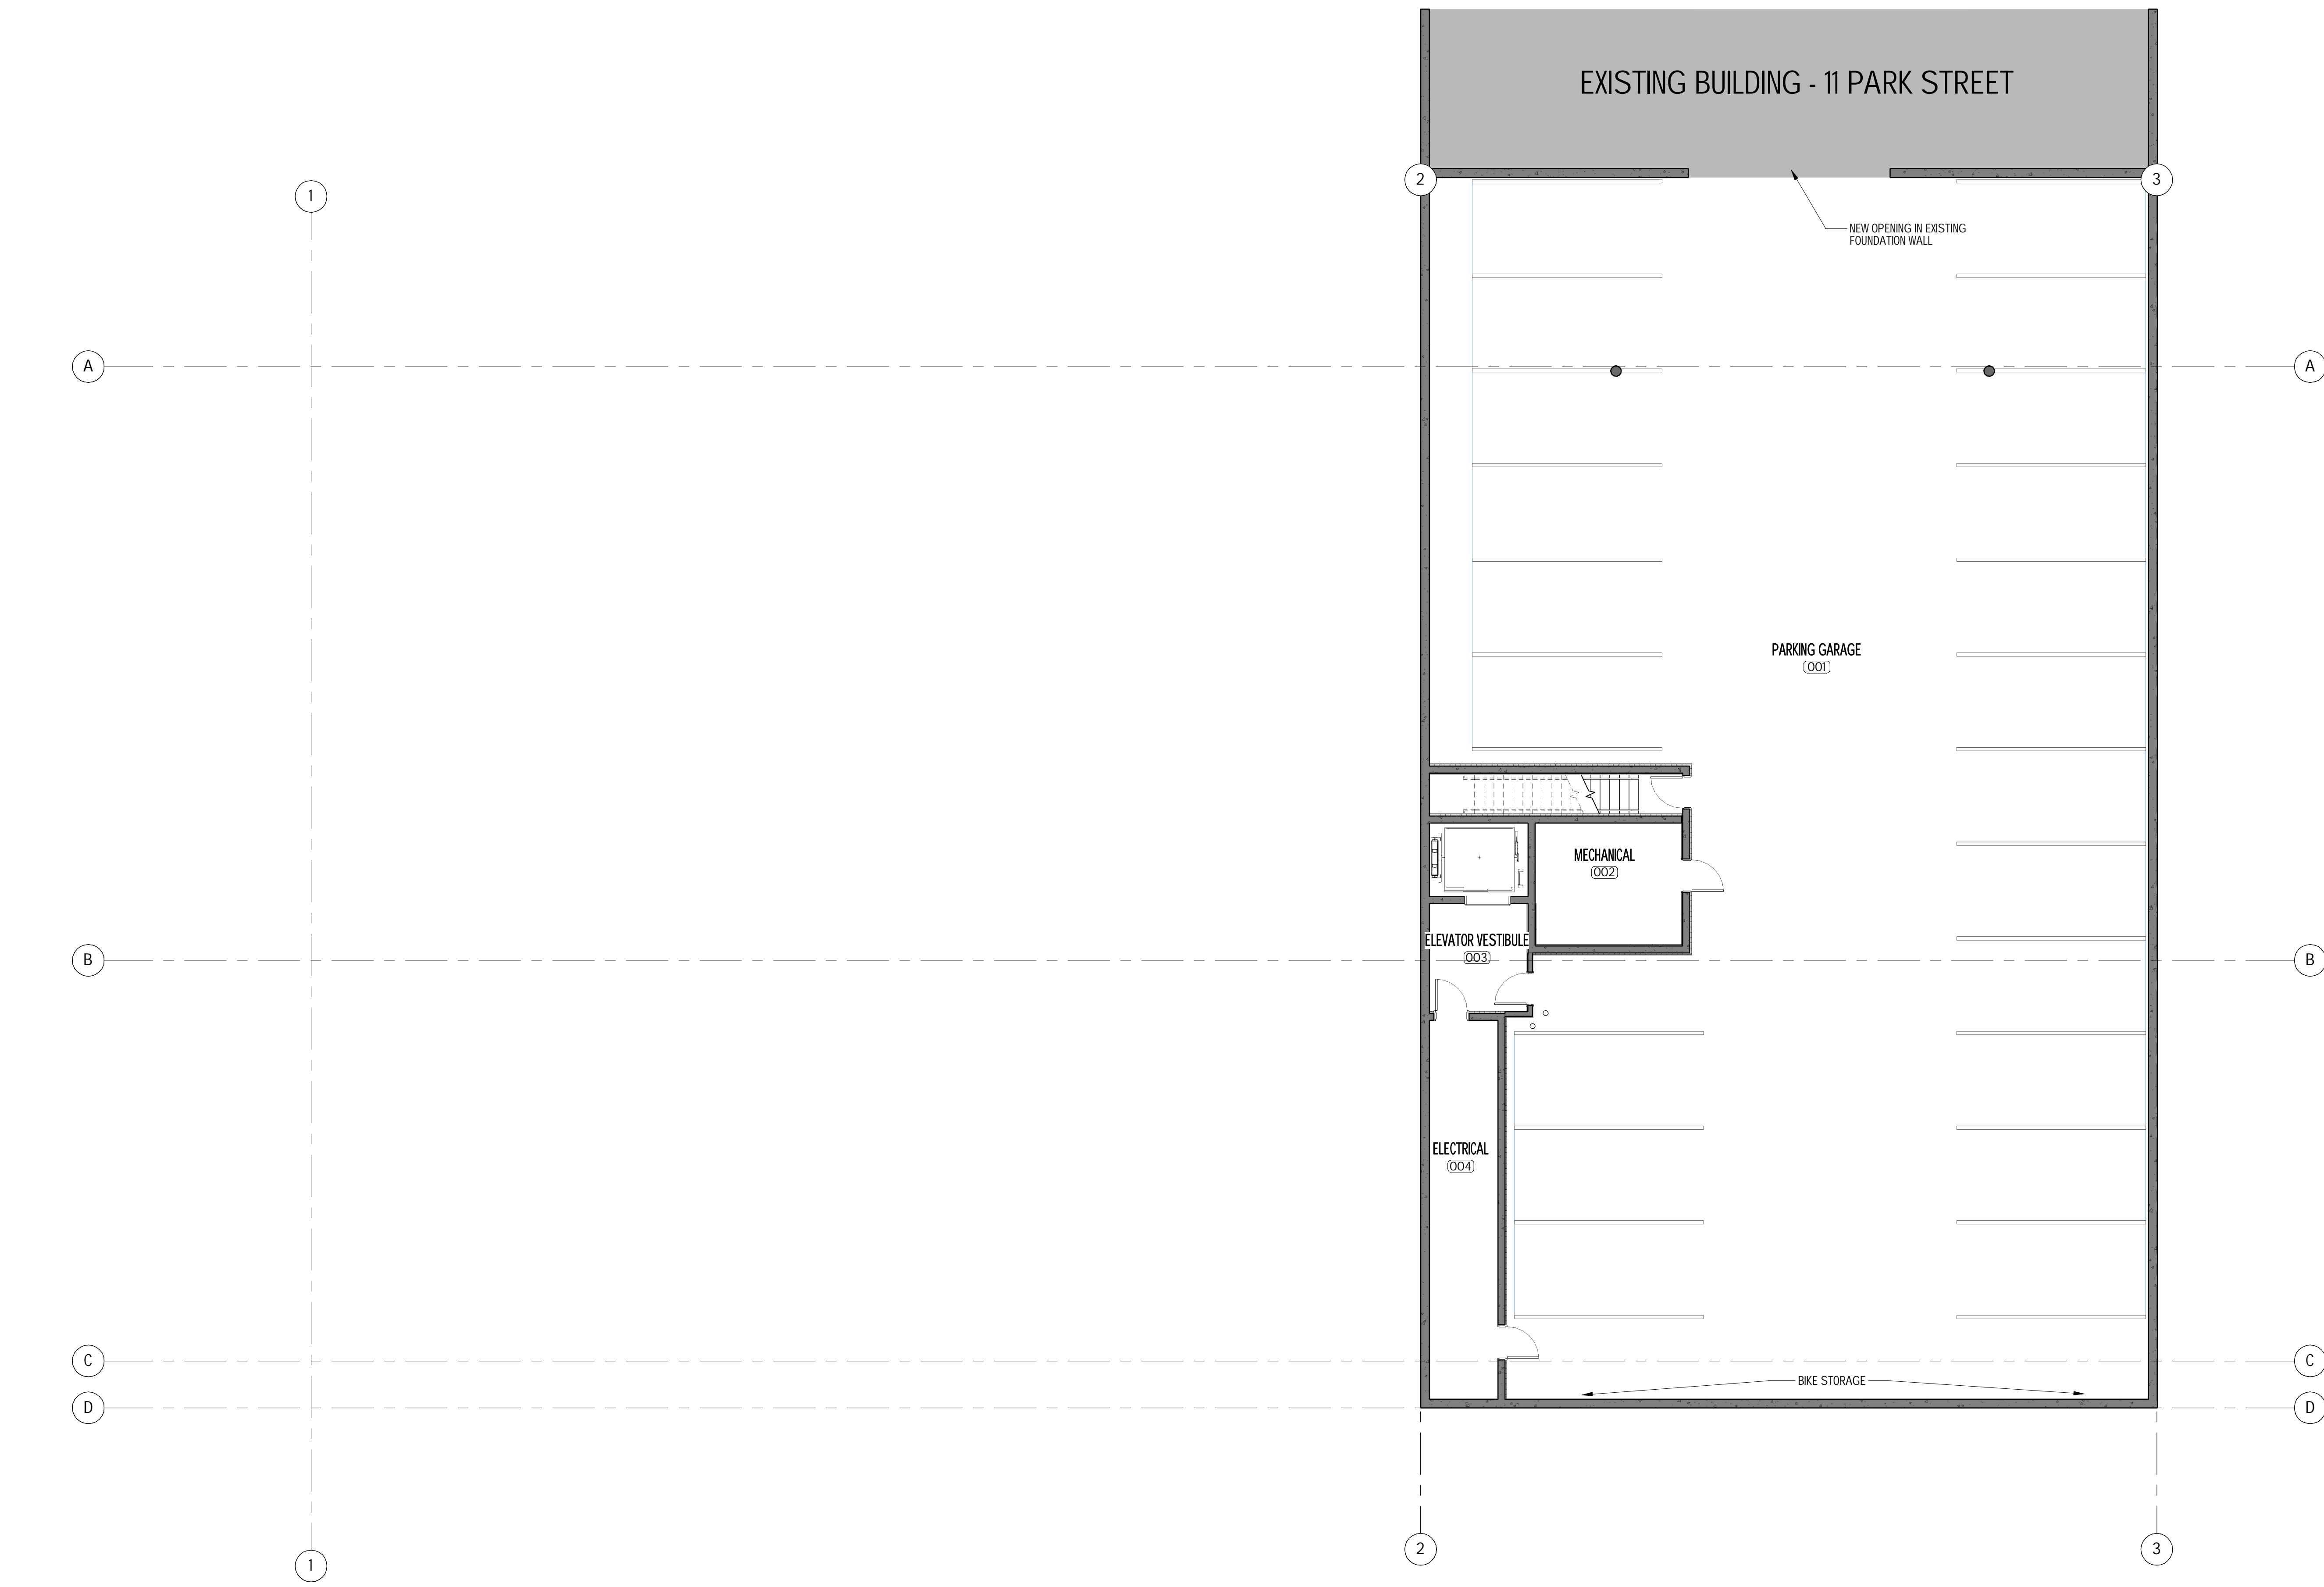

1 GARAGE FLOOR PLAN
1/8" = 1'-0"

REVISIONS	
No.	Description

FIRST FLOOR PLAN
SCALE: 1/8" = 1'-0"

17 PARK STREET
CITY OF ESSEX JUNCTION, VERMONT

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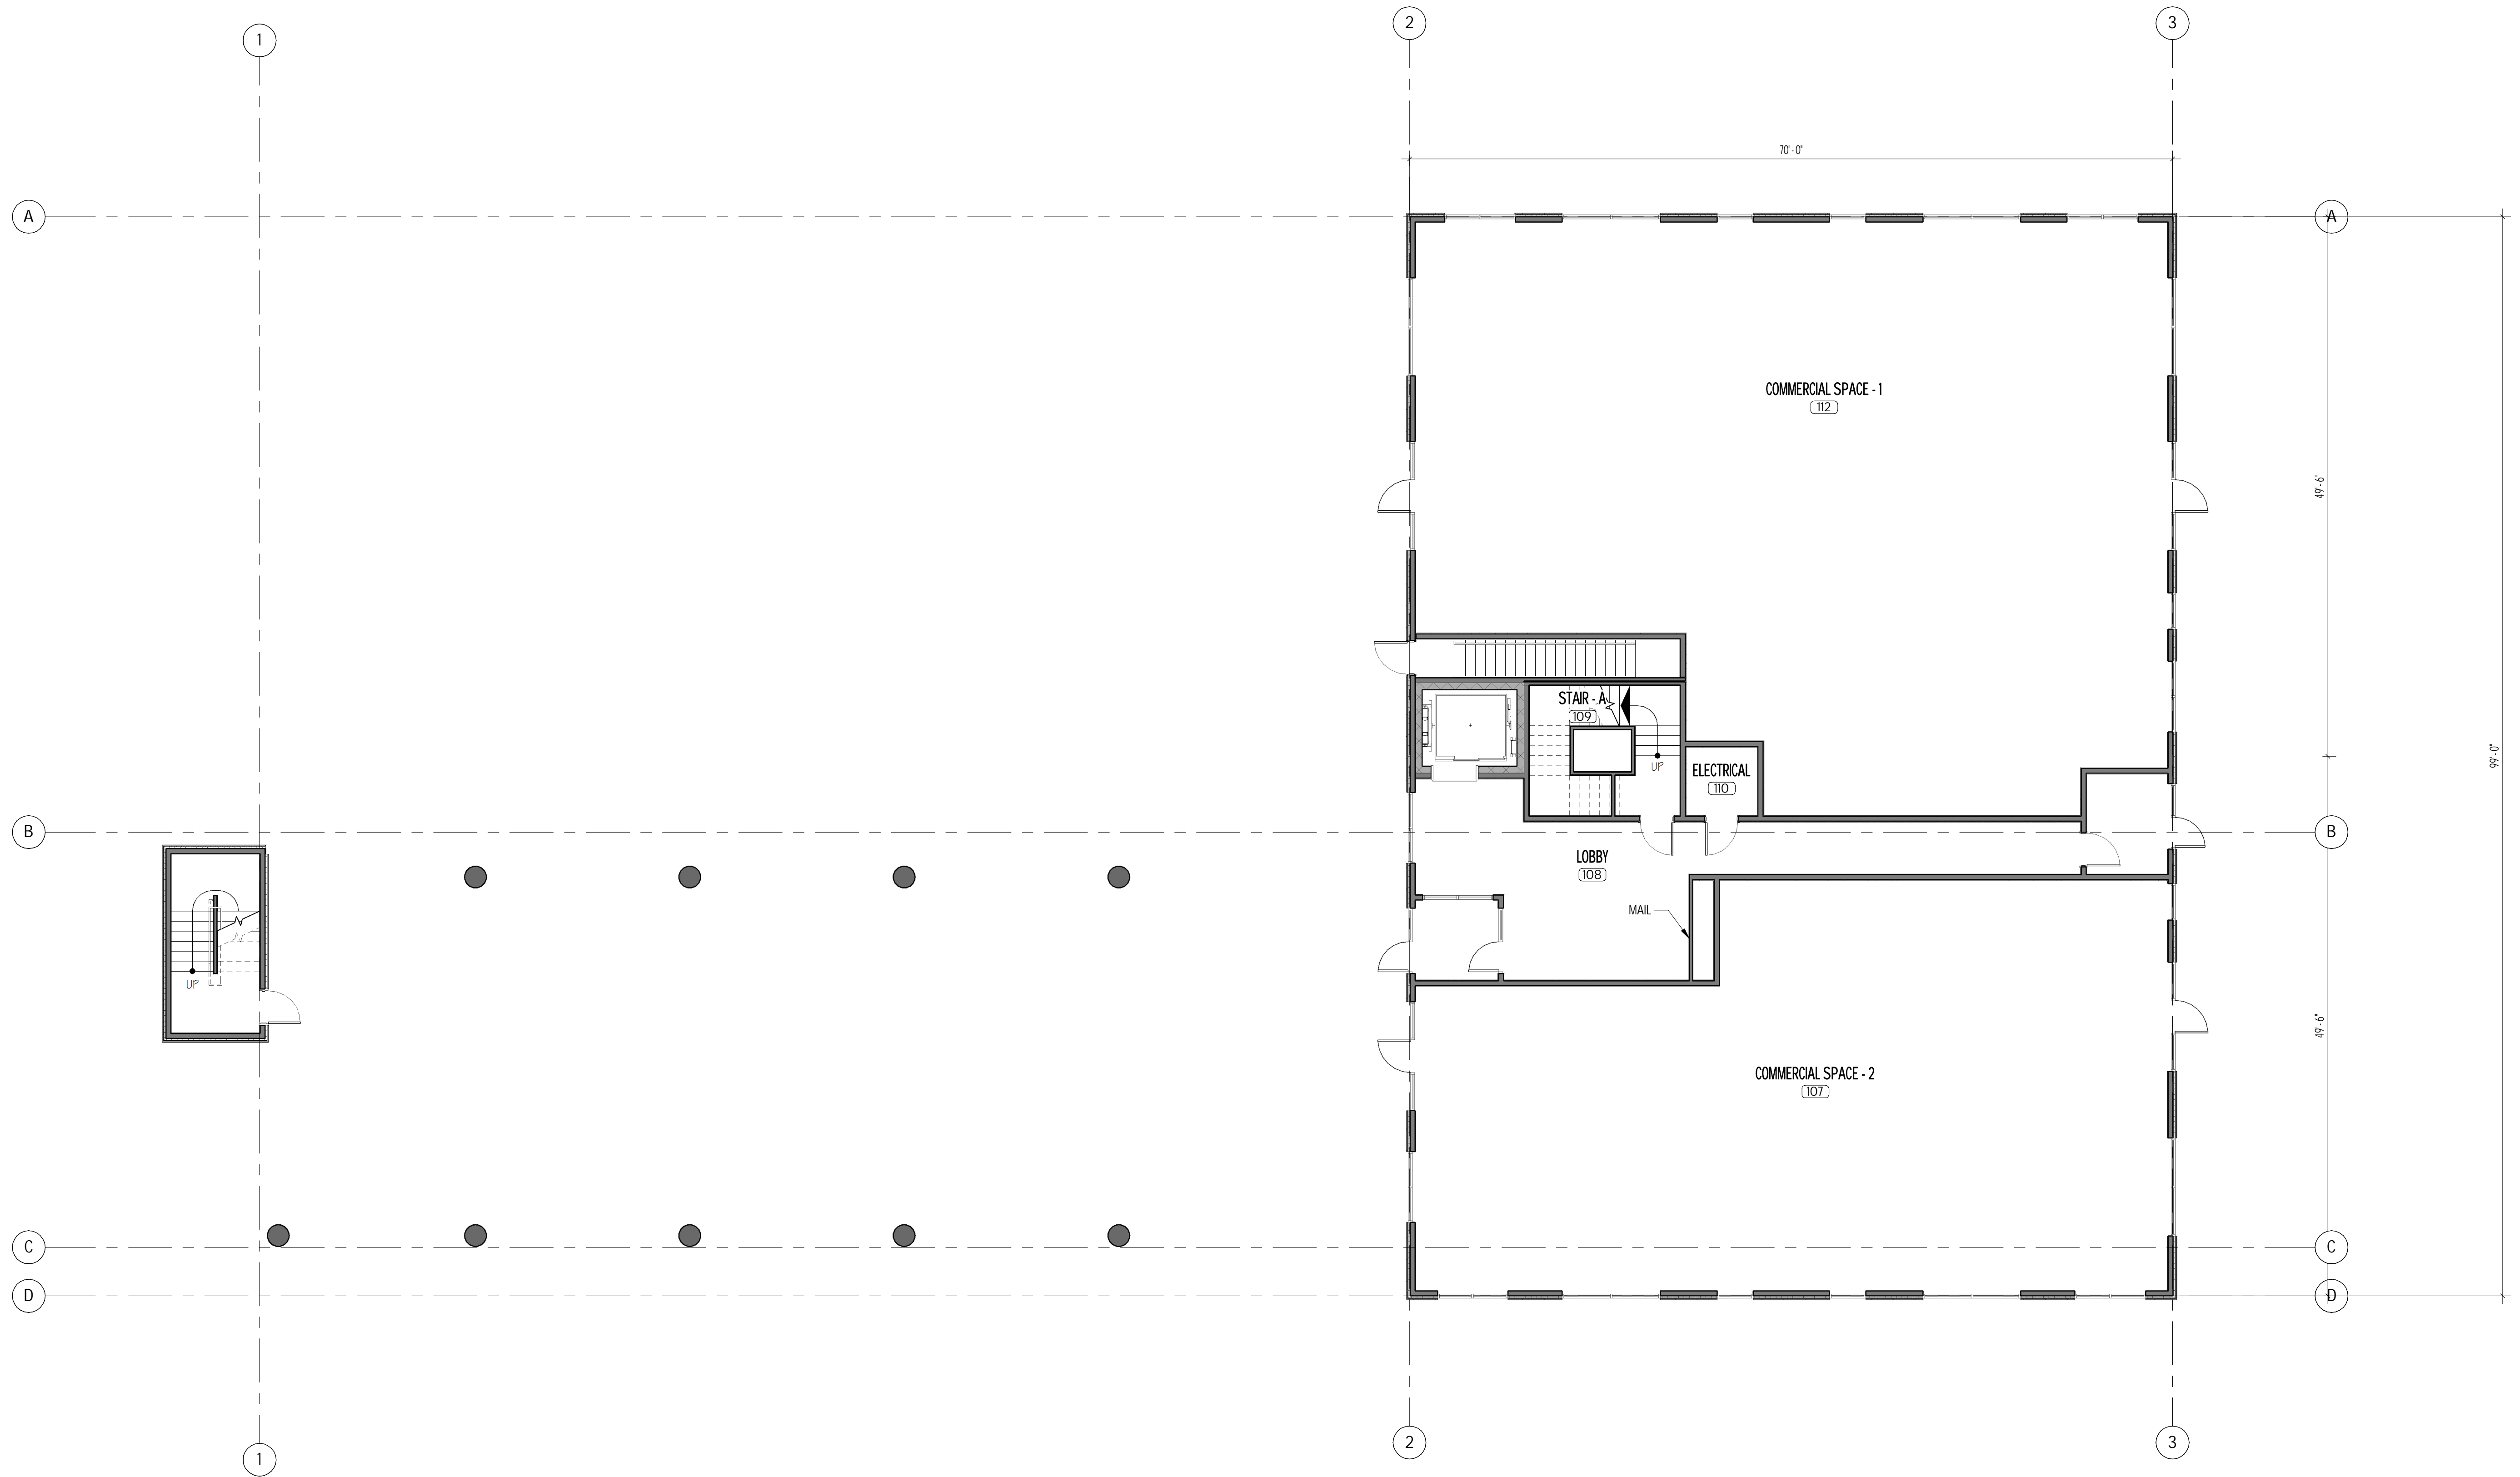


PROJECT #: 2005

SHEET NUMBER

A102

03/10/21



1 FIRST FLOOR PLAN
1/8" = 1'-0"

No.	Description	Date

THIRD FLOOR PLAN
SCALE: 1/8" = 1'-0"
17 PARK STREET
CITY OF ESSEX JUNCTION, VERMONT




PROJECT #: 2005

SHEET NUMBER

A104

10/23/23

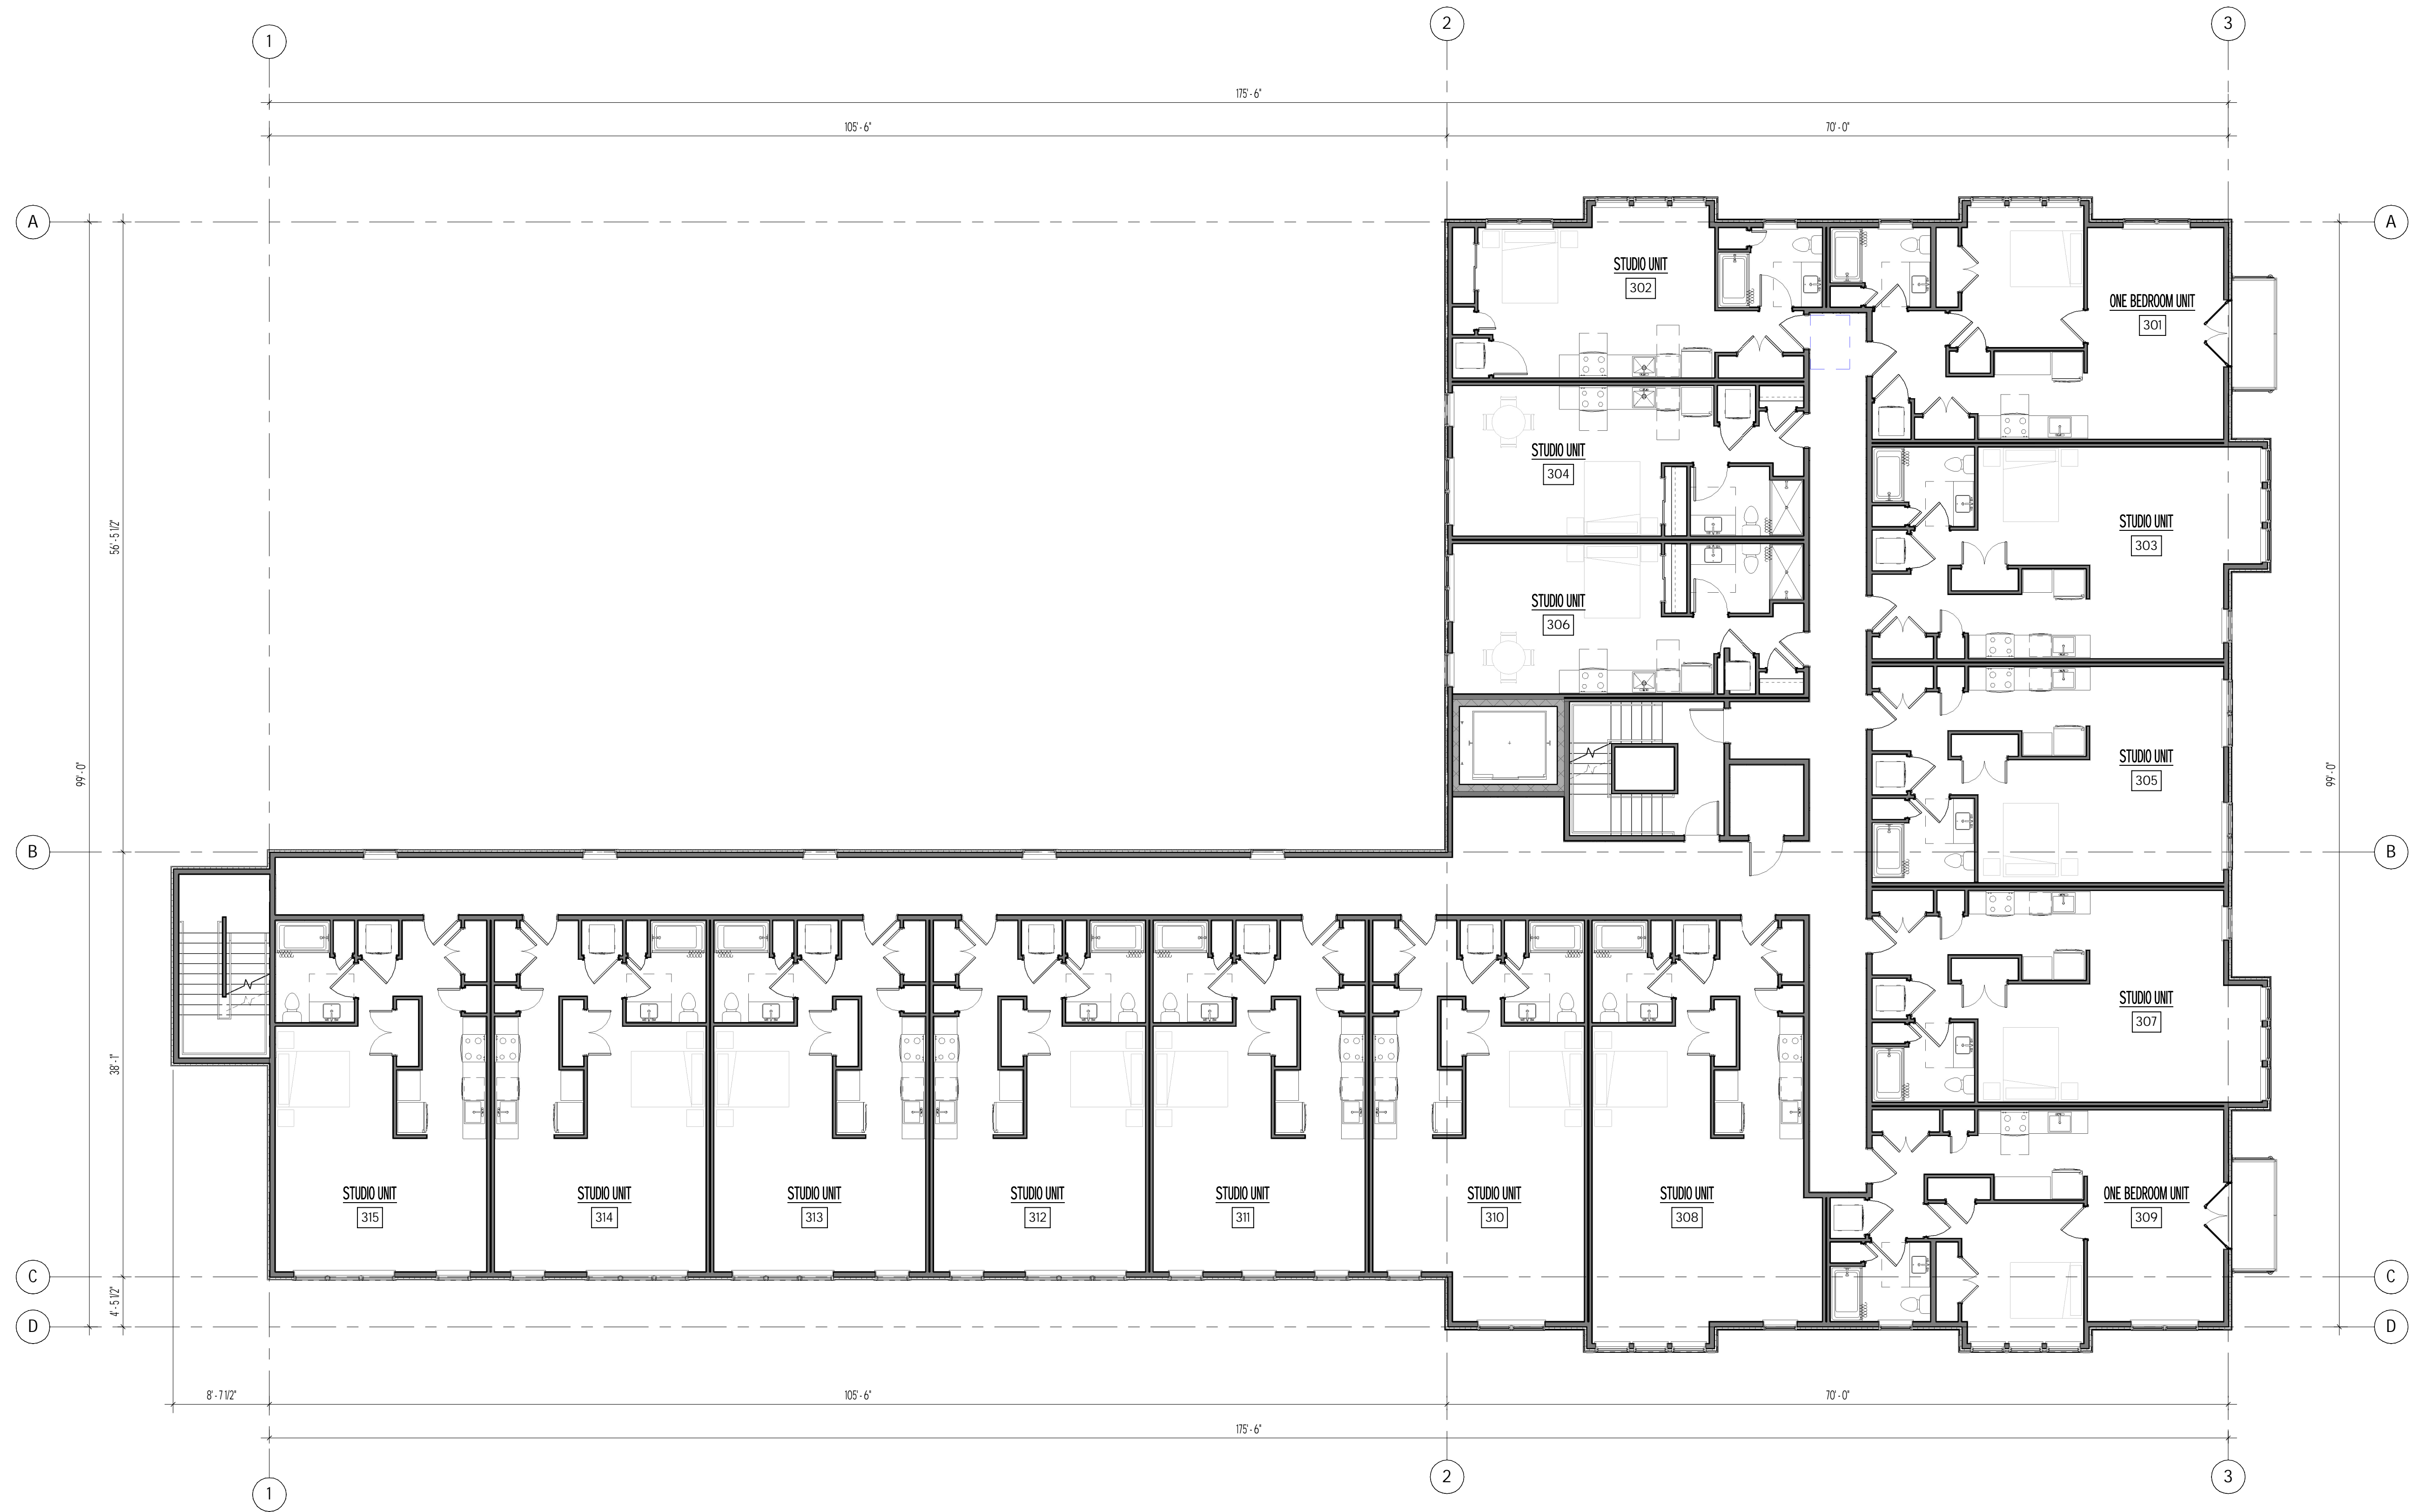

1 THIRD FLOOR PLAN
1/8" = 1'-0"

PRELIMINARY
NOT FOR
CONSTRUCTION

Date

REVISIONS
Description

No.

FOURTH FLOOR PLAN
SCALE: 1/8" = 1'-0"

17 PARK STREET
CITY OF ESSEX JUNCTION, VERMONT

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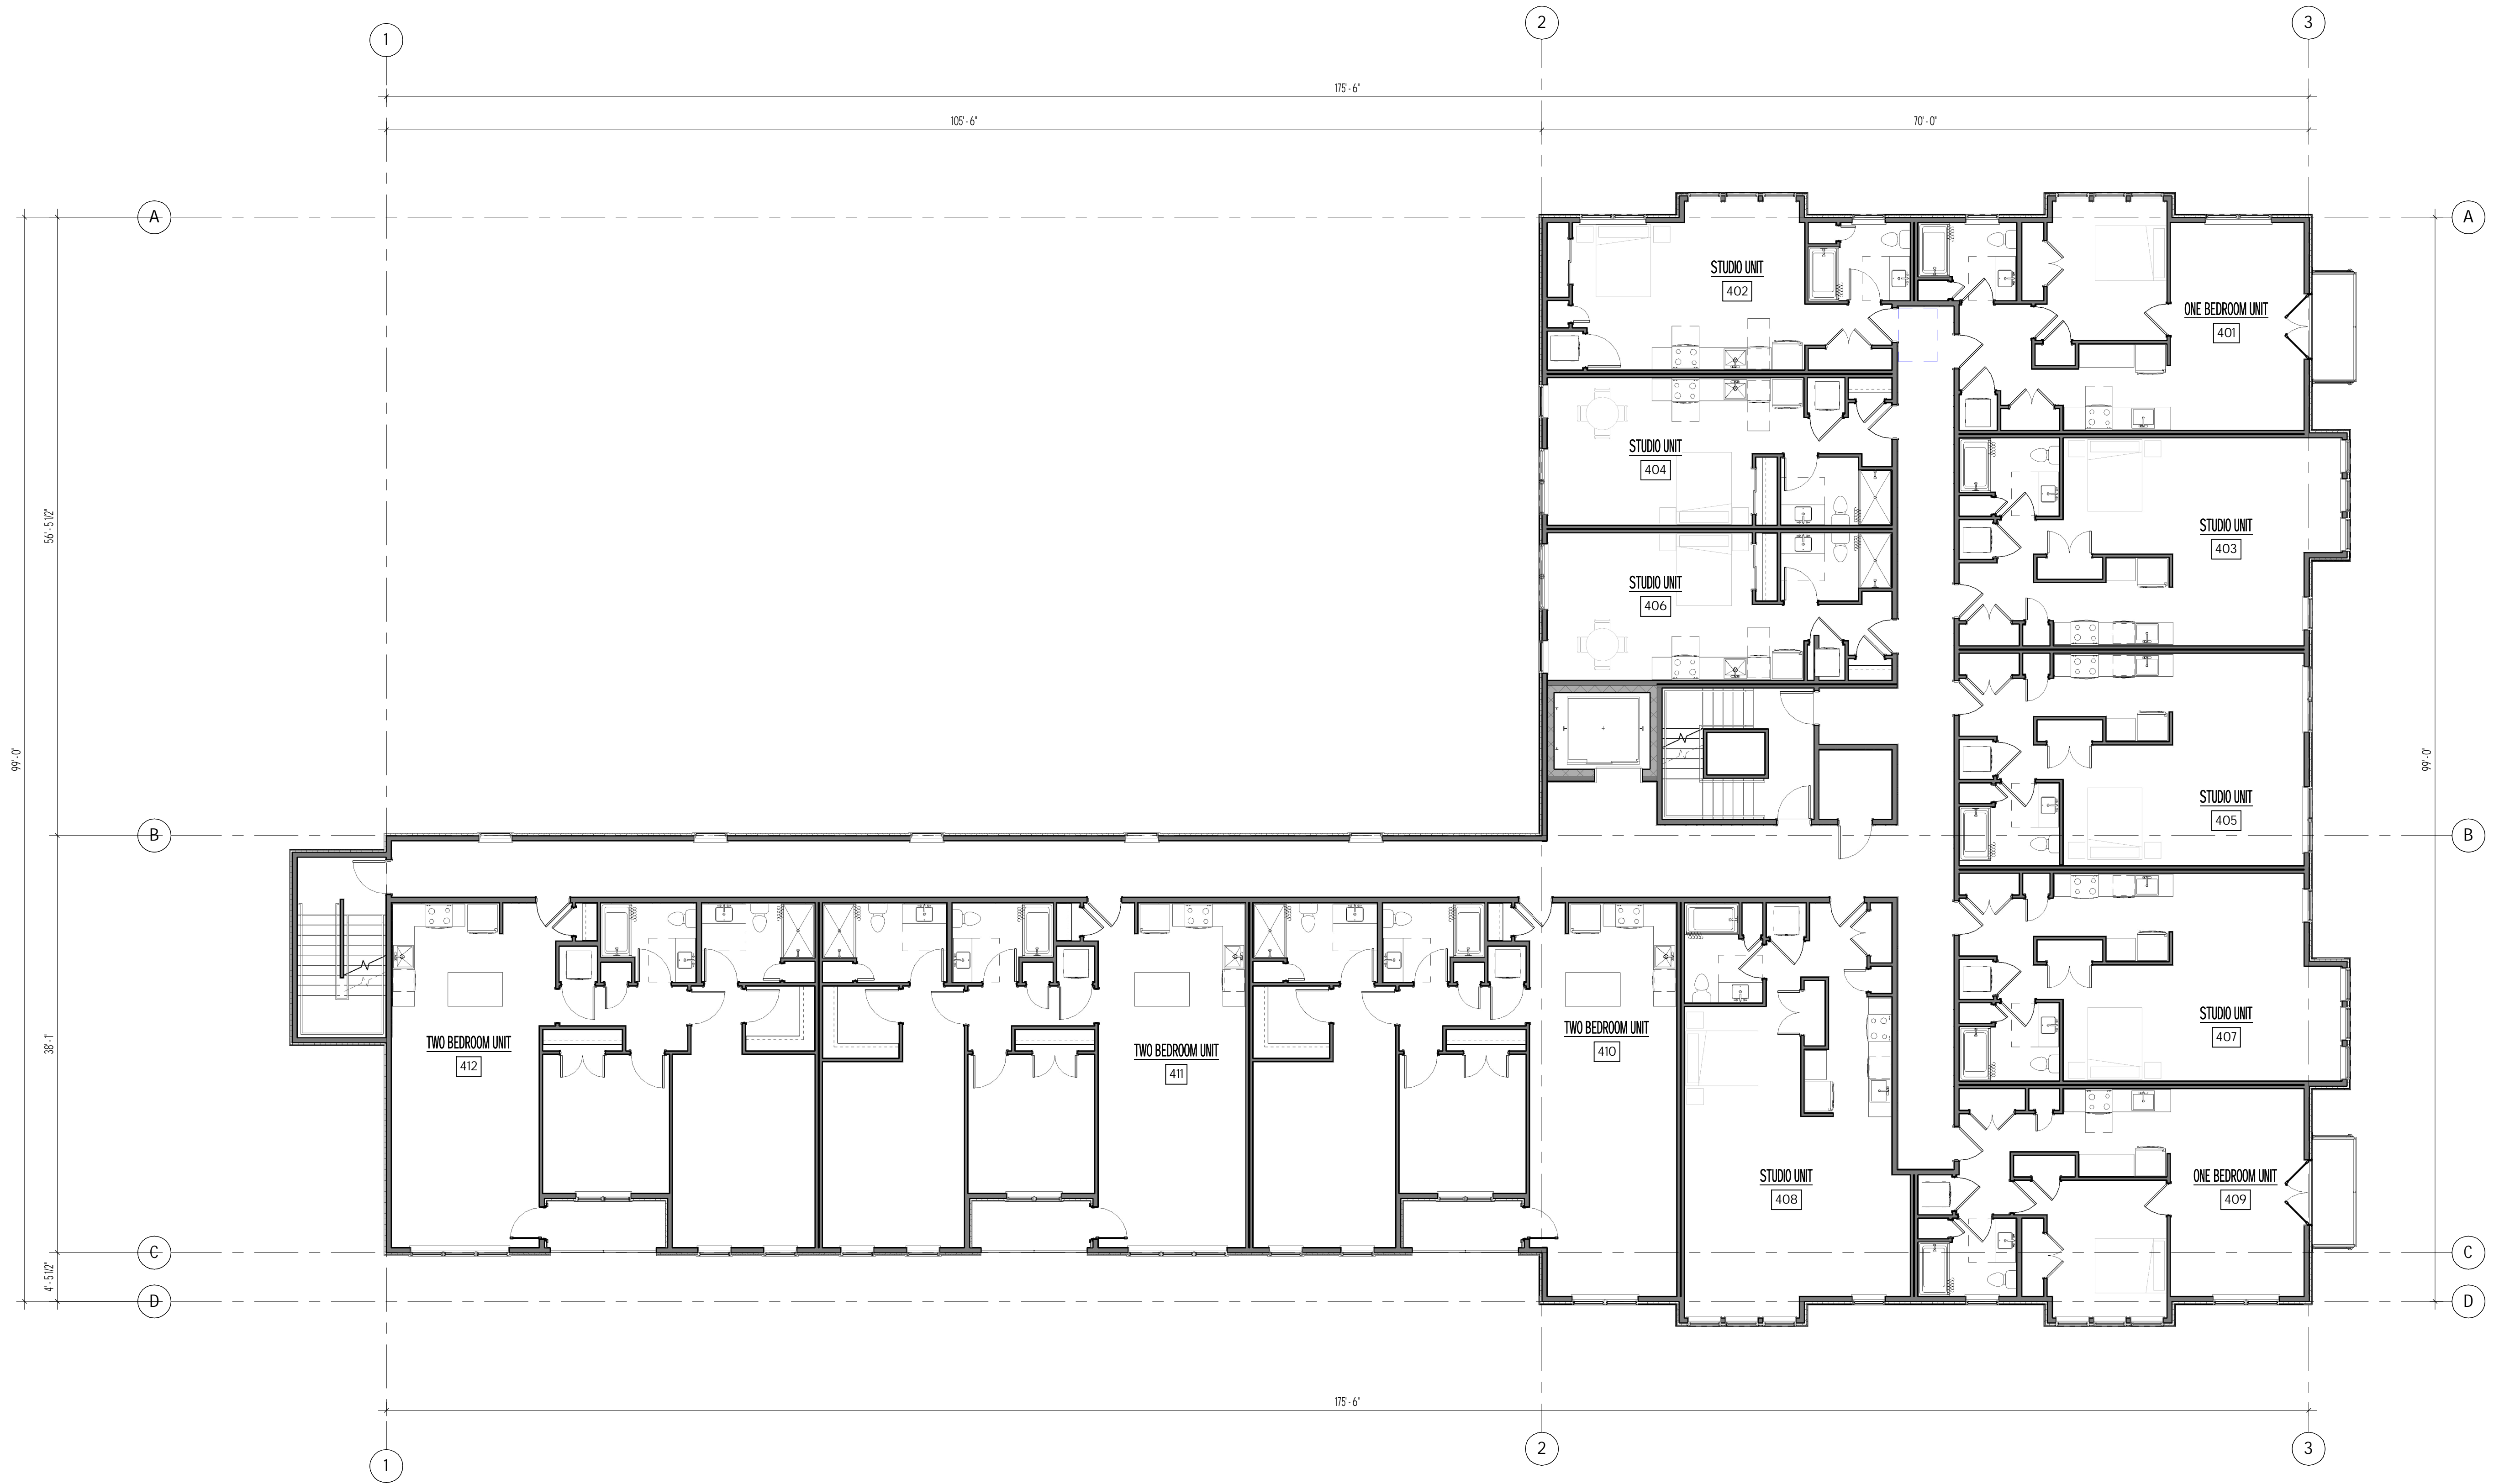


PROJECT #: 2005

SHEET NUMBER

A105

09/20/23



1 FOURTH FLOOR PLAN
1/8" = 1'-0"

PRELIMINARY
NOT FOR
CONSTRUCTION

No.	Description	Date

FIFTH FLOOR PLAN
SCALE: 1/8" = 1'-0"
17 PARK STREET
CITY OF ESSEX JUNCTION, VERMONT




PROJECT #: 2005

SHEET NUMBER

A106

10/23/23

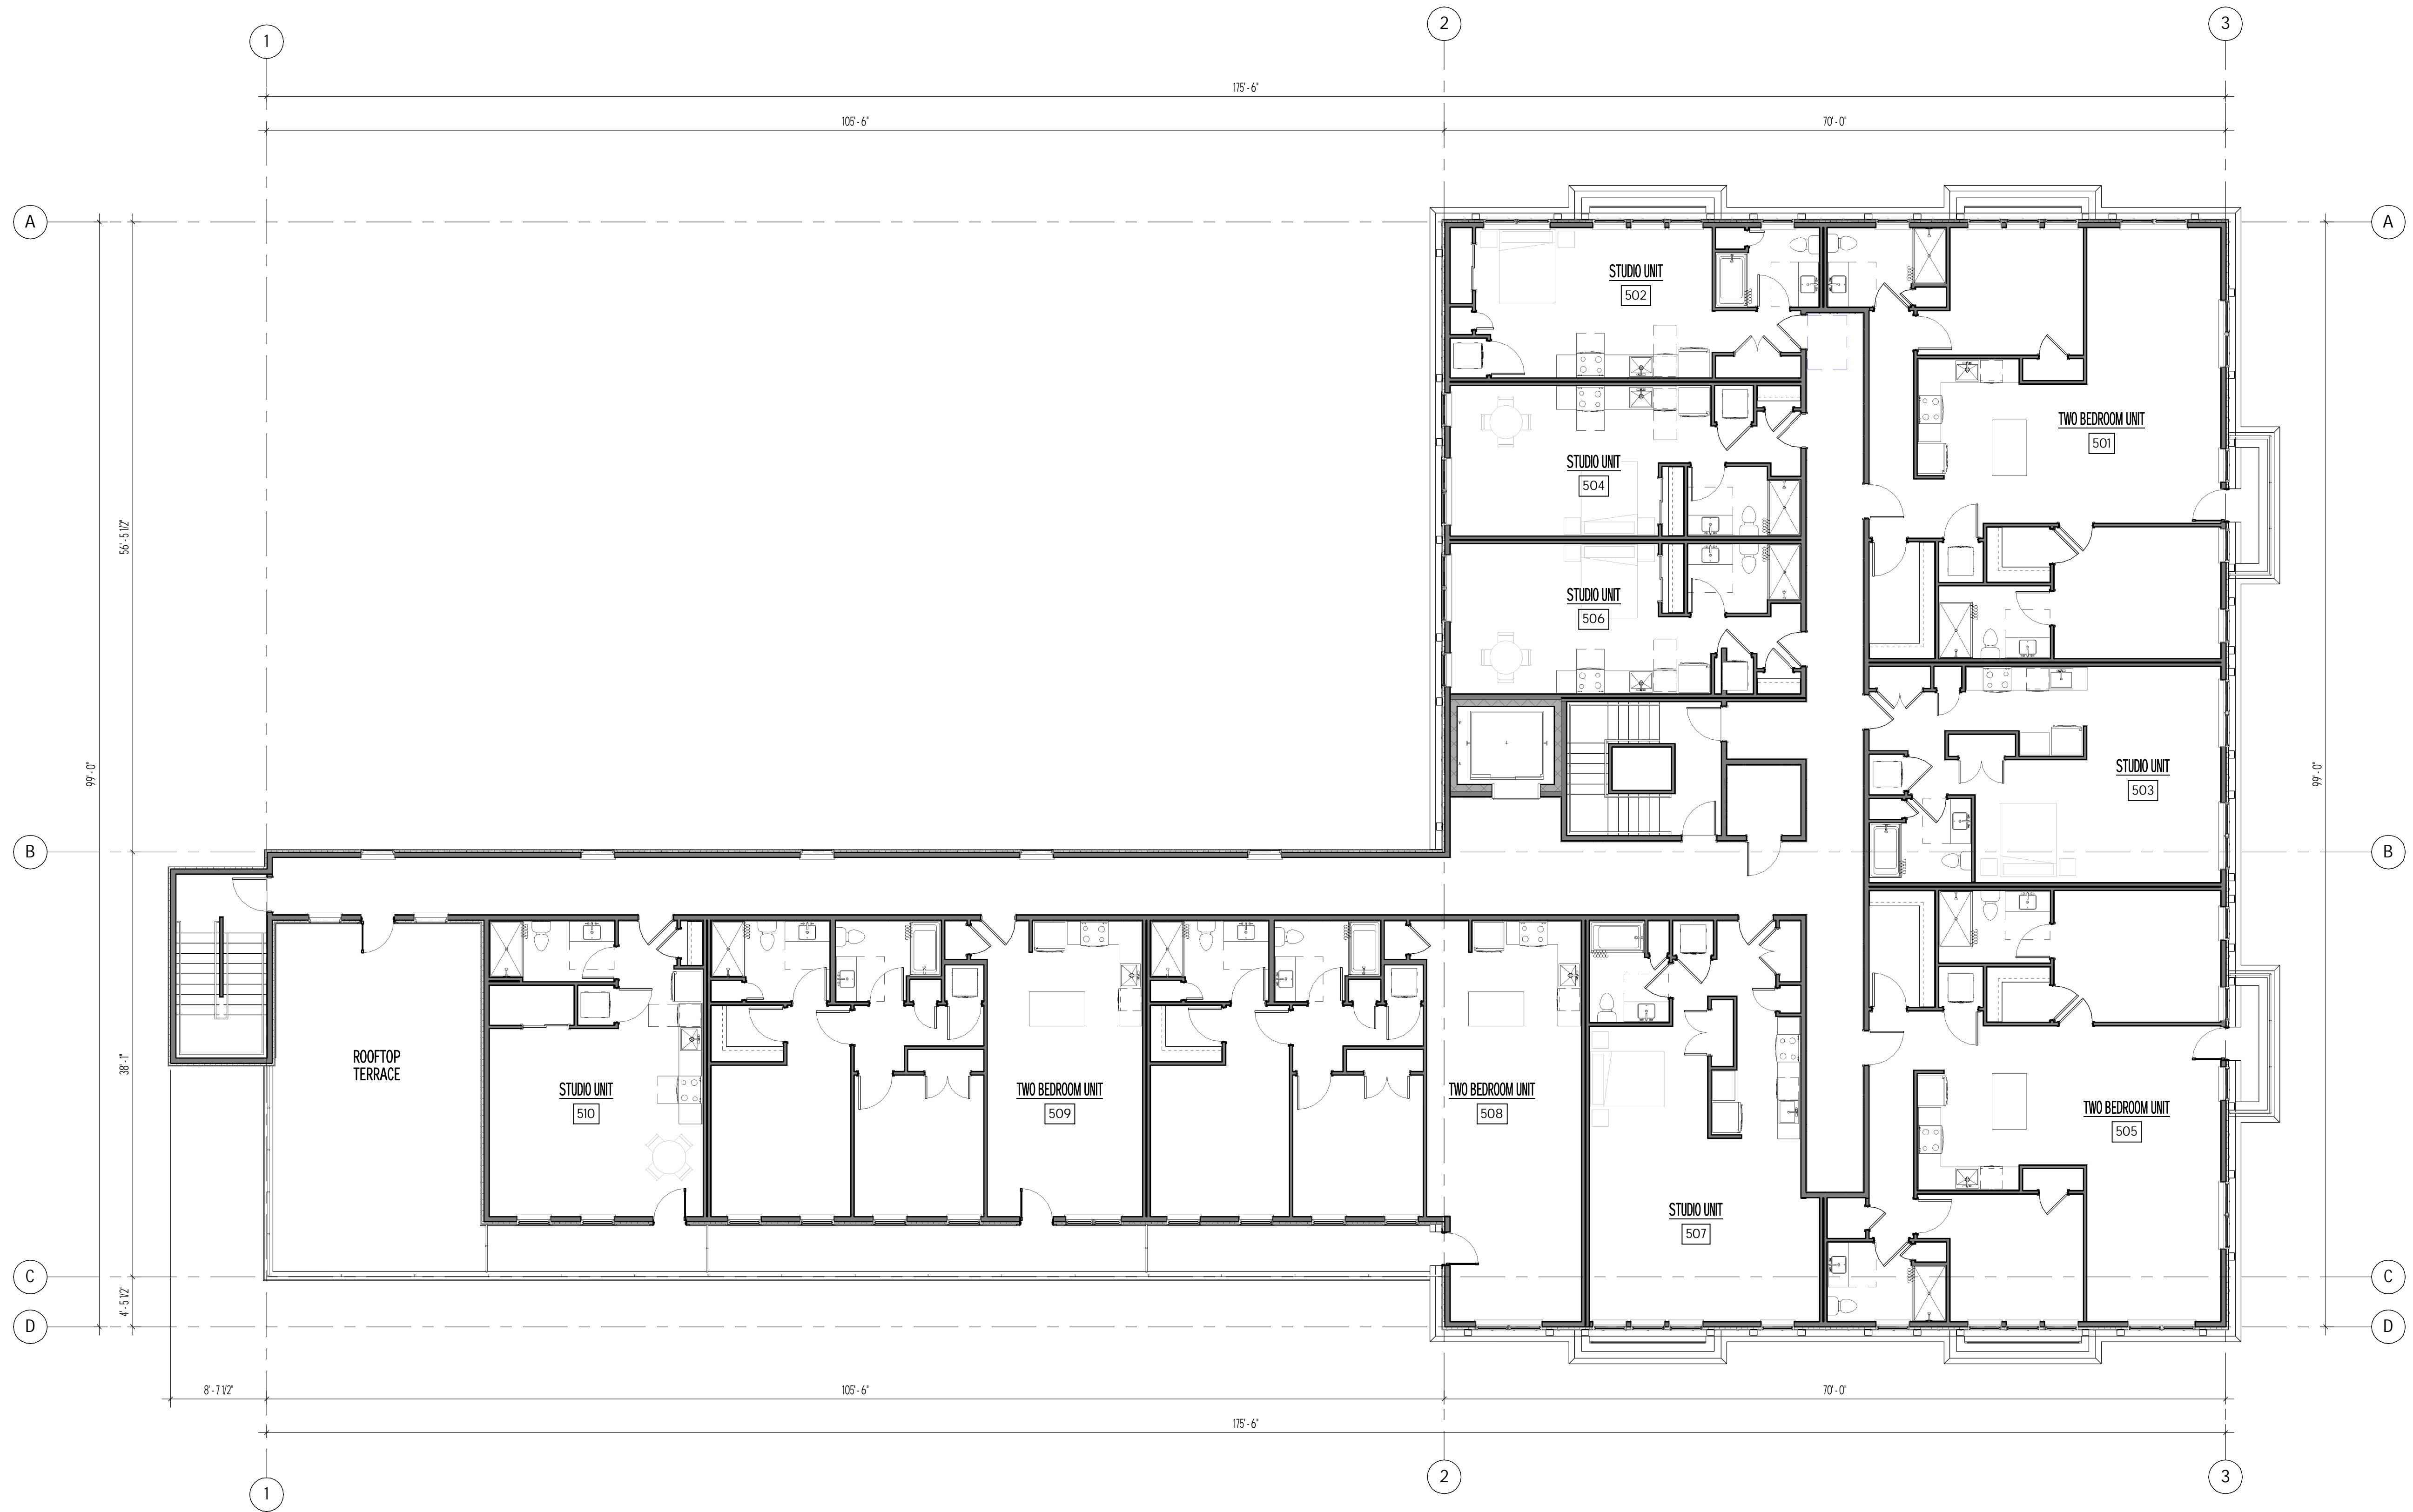

1 FIFTH FLOOR PLAN
1/8" = 1'-0"



① SOUTH ELEVATION
1/8" = 1'-0"



② EAST ELEVATION
1/8" = 1'-0"

EXTERIOR MATERIAL LEGEND	
E-1	SIDING TYPE ONE - FIBER CEMENT SIDING - NOVENARY DIMENSIONAL SERIES BY NICHIA. COLOR TO BE SLATE
E-2	SIDING TYPE TWO - FIBER CEMENT LAP SIDING - HARDIE PLANK LAP SIDING SMOOTH BY JAMES HARDIE. COLOR TO BE PEARL GRAY
E-3	SIDING TYPE THREE - FIBER CEMENT LAP SIDING - HARDIE PLANK LAP SIDING SMOOTH BY JAMES HARDIE. COLOR TO BE LIGHT MIST
E-4	SIDING TYPE FOUR - FIBER CEMENT BOARD AND BATTEN SIDING - HARDIE PANEL VERTICAL SIDING SMOOTH, WITH 2 INCH BATTENS. COLOR TO BE GRAY SLATE
E-5	SIDING TYPE FIVE - INFILL PANELS - HARDIE PANEL SMOOTH BY JAMES HARDIE. COLOR TO BE GRAY SLATE
E-6	SIDING TYPE SIX - FIBER CEMENT LAP SIDING - VINTAGEWOOD, WOOD SERIES BY NICHIA. COLOR TO BE BARK.
E-7	SIDING TYPE SEVEN - HARDIE SINGLE SIDING - STRAIGHT EDGE PANEL. COLOR TO BE LIGHT MIST.
E-8	BALCONIES - WOOD FRAMED BALCONY WITH GLASS RAILING SYSTEM. BALCONIES PAINTED SHERWIN WILLIAMS TRICORN BLACK OR APPROVED EQUAL
E-9	ENTRY DOOR - SEE DOOR SCHEDULE FOR SIZE AND MATERIAL. DOORS MUST MEET U-VALUE SPECIFIED IN BUILDING ENVELOPE REQUIREMENTS ON SHEET A010. COLOR AS SELECTED BY ARCHITECT.
E-10	CORNICE - WOOD FRAMED PARAPET AND CORNICE. FACIA TO BE COMPOSITE TRIM BOARD. SOFFIT TO BE SHEATHED WITH FIBER CEMENT PANEL OR APPROVED EQUAL
E-11	TRIM BOARDS - 5/4 TRIM. SIZES AS INDICATED. SMOOTH TEXTURE. COLOR TO BE SHERWIN WILLIAMS TRICORN BLACK OR APPROVED EQUAL
E-13	WINDOWS - VINYL WINDOWS. WINDOWS MUST MEET U-VALUE SPECIFIED IN BUILDING ENVELOPE REQUIREMENTS. COLOR TO BE BLACK.
E-14	STOREFRONT SYSTEM - FIBERGLASS OR ALUMINUM STOREFRONT SYSTEM AND INTEGRATED ENTRY DOORS. STOREFRONT MUST MEET U-VALUE REQUIREMENTS SPECIFIED IN BUILDING ENVELOPE REQUIREMENTS.
E-15	CORNICE BRACKETS - BRACKETS MADE WITH COMPOSITE POLYUREA, HIGH DENSITY URETHANE, GLASS FIBER REINFORCED GYPSUM OR OTHER APPROVED METHOD. BRACKETS FINISHED AND PAINTED TO MATCH PEARL GRAY SIDING.
E-16	MID-BUILDING BANDING - MADE WITH COMPOSITE POLYUREA, HIGH DENSITY URETHANE, GLASS FIBER REINFORCED GYPSUM OR OTHER APPROVED METHOD. PROVIDE PROFILED BANDING. PAINTED TO BE SHERWIN WILLIAMS TRICORN BLACK OR APPROVED EQUAL.

Date

REVISIONS
Description

No.

EXTERIOR ELEVATIONS
SCALE: 1/8" = 1'-0"

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PROJECT #: 2005

SHEET NUMBER

A201

10/20/23



① SOUTHEAST PERSPECTIVE

PRELIMINARY
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CONSTRUCTION

No.	Description	Date

PERSPECTIVE
SCALE:

17 PARK STREET
CITY OF ESSEX JUNCTION, VERMONT



PROJECT #: 2005

SHEET NUMBER

A901

10/19/21